



CRACK CONTROL JOINT

CONSTRUCTION JOINT

TYPICAL CONCRETE WALL VERTICAL JOINT DETAILS NOT TO SCALE

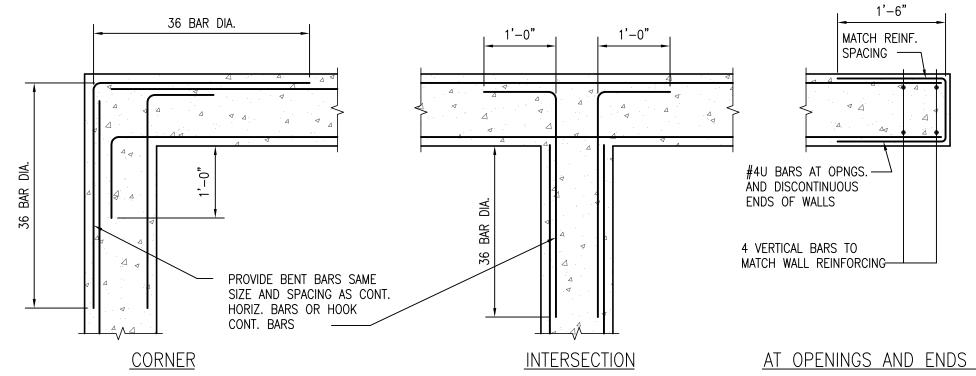

TYPICAL WALL HORIZONTAL REINFORCING DETAILS

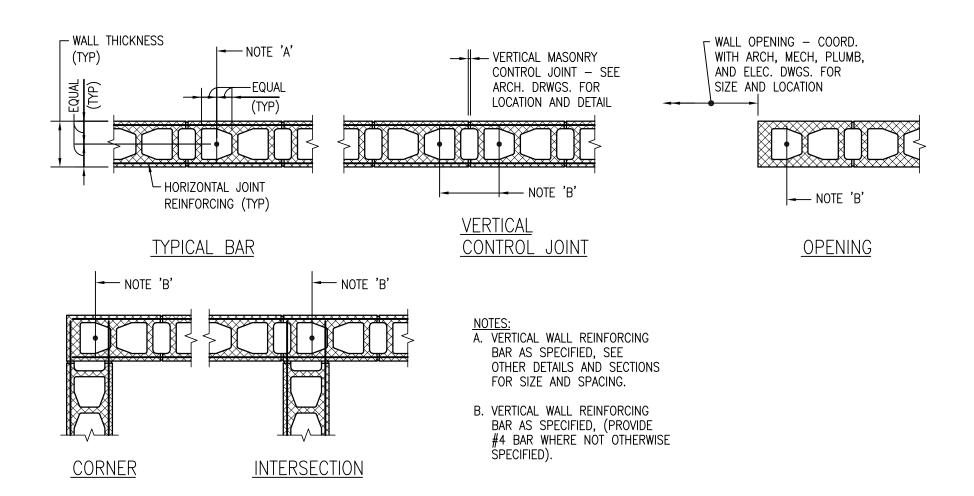

TYPICAL CONCRETE MASONRY VERTICAL WALL REINFORCING DETAILS

			NCRETE MASONRY DRCING SCHEDULE
WALL LOCATION	WALL THICKNESS	VERTICAL REINFORCING	HORIZONTAL REINFORCING
ALL EXTERIOR, LOAD BEARING,	8"	#5 @ 32"	STD LADDER TYPE REINF. @ 16"O.C.
SHEARWALL, STAIR, ELEVATOR WALLS	12"	#7 @ 48"	EXTRA HEAVRY LADDER TYPE REINF. @ 16"O.C.
ALL OTHER INTERIOR CMU PARTITION WALLS	ALL SIZES	#4 © 96"	STD LADDER TYPE REINF. @ 16"o.c. + 1-#4 IN BOND BEAM @ 96"o.c.
REQUIREI 2. PROVIDE PROVIDE 3. ALL VER AND PRO	MENTS MORE S REINFORCED E 2#5 BARS AT TICAL REINFORCE OVIDE 48 DIA L	STRINGENT THAN BOND BEAM WITH B" BOND BEAM CING TO BE IN	FOR REINFORCING IN THE SCHEDULE HIN 16" OF TOP OF WALL. MS, 2#6 AT 12" BOND BEAMS. SOLIDLY GROUTED CELLS, SPLICES. TYPICAL G.

CMU REINFORCING SCHEDULE

CONC	RETE REINF	ORCING SF	LICE SCHE	DULE
LAP SPLICE		TENSION LAP SF	PLICE	
CONCRETE	fc'=30	000 psi	fc'=40	000 psi
BAR SIZE	TOP BARS	OTHER BARS	TOP BARS	OTHER BARS
#3	28"	21"	24"	19"
#4	37"	29"	32"	25"
#5	46"	36"	40"	31"
#6	56"	43"	48"	37"
#7	81"	63"	70"	53"
#8	93"	72"	79"	61"


NOTES:

1. ALL SPLICES ARE LAP SPLICE UNLESS OTHERWISE IN SECTION. 2. A TOP BAR IS HORIZONTAL WITH AT LEAST 12" OF FRESH CONCRETE BELOW. 3. EXPOXY-COATED REINFORCING SPLICES SHALL BE INCREASED ACCORDING TO ACI 318.


_ KERF WEBS OF UNITS TO

ALLOW PLACEMENT OF

CONCRETE REINFORCING SPLICE SCHEDULE

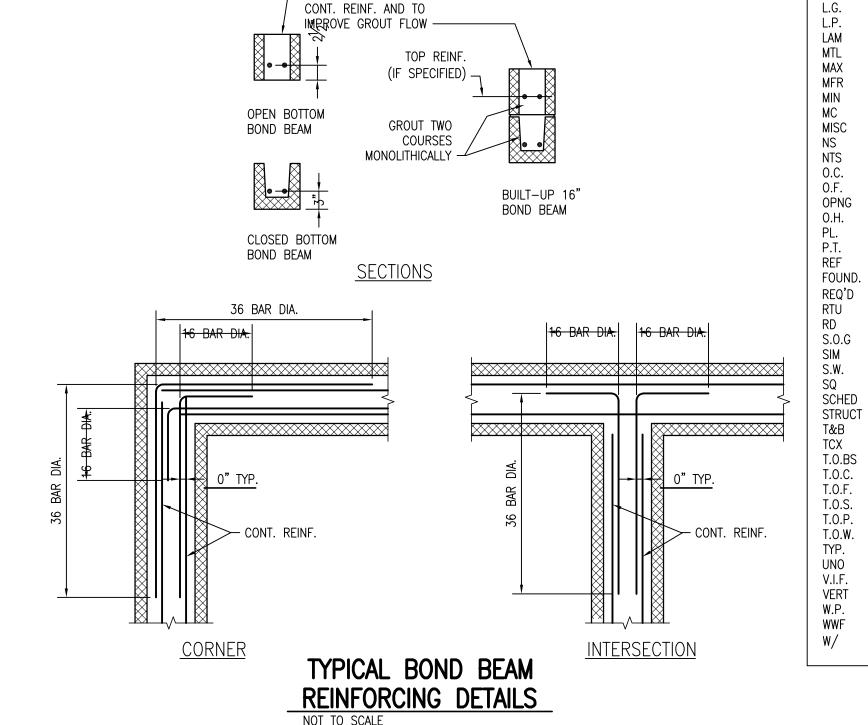

#4 DOWEL

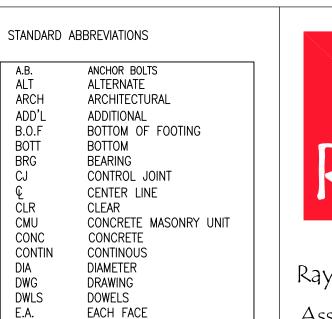

ARCH

ADD'L B.O.F

BOTT BRG CJ

CLR

CMU

DIA

DWG DWLS E.A.

E.W.

ELEV. EQ

EXIST EXT

FOUND.

FTG

GA

GALV. GB

HK H.P.

HSS I.F.

LOD LLH

LLV

L.W.

HORIZ

CONC

CONTIN

BOTTOM

BEARING

CLEAR

CONCRETE

DIAMETER

EACH WAY EXPENSION JOINT

ELEVATION EQUAL

EXISTING

EXTERIOR

FAR SIDE

FOOTING

GAUGE

HOOK

GALVANIZED

HIGH POINT

HORIZONTAL

INSIDE FACE

LONG WAY

LIGHT GAGE

LOW POINT

PARALLAM

METAL

MAXIMUM

MINIMUM

MANUFACTURER

MISCELLANIES

NOT TO SCALE

OPPOSITE HAND

PRESSURE TREATED

NEAR SIDE

ON CENTER OUTSIDE FACE

OPENING

REFERENCE

REINFORCING

ROOF DRAIN

ROOF TOP UNIT

SLAB ON GRADE

REQUIRED

SIMILAR

SQUARE

SCHEDULE

STRUCTURAL

TOP AND BOTTOM

TOP CHORD EXTENSION

UNLESS NOTED OTHERWISE

TOP OF BRICK SHELF

TOP OF CONCRETE TOP OF FOOTING TOP OF STEEL TOP OF PIER

TOP OF WALL

VERIFY IN FIELD

WELDED WIRE FABRIC

TYPICAL

VERTICAL

WITH

WORK POINT

SHORT WAY

PLATE

MOMENT CONNECTION

LIMIT OF DECK

LONG LEG HORIZONTA

LONG LEG VERTICAL

HOLLOW STRUCTURAL STEEL

GRADE BEAM

FOUNDATION

FINISHED FLOOR

DRAWING DOWELS

Raymond Design Associates, Inc.

222 North Street Hingham, MA 02043



HIGH SCHOOL

Y BUILDING

SIS ROAD

SACHUSETTS 02459 NEWTON FIELD

Revisions:

04.05.10

Drawn By:

Checked By:

Approved By:

Drawing Scale:

Project Number: 10025

No. Date Description

09.08.11 | BID SET

PES

DAJ

RRC

09.08.11

ETAILS

TYPICAL

SEE ELECTRICAL DWGS.
FOR ADD'L INFORMATION - #4 DOWEL

ELEVATION A-A

ONE (1) LOCATION MINIMUM REQUIRED PER BUILDING, SEE ELECTRICAL DRAWINGS. COORDINATE WITH GENERAL CONTRACTOR FOR LOCATION OF REBAR CONNECTION AND TO PROVIDE ACCESS TO THE REBAR CONNECTION UNTIL ELECTRICAL INSTALLATION AND INSPECTION ARE COMPLETE.

 $\frac{1}{2}$ " MIN. BARE REBAR (#4 MIN.) x 22'-0" LONG - OR 22'-0" OF #4 AWG BARE COPPER CONDUCTOR

TO MEET THE REQUIREMENTS OF NEC ARTICLE 250

FOR CONCRETE-ENCASED ELECTRODES

CONCRETE ENCASED GROUNDING ELECTRODE DETAIL

NOT TO SCALE


SEE PLAN

<u>SECTION</u>

FOUND. WALL -

BID SET

SHEET OF

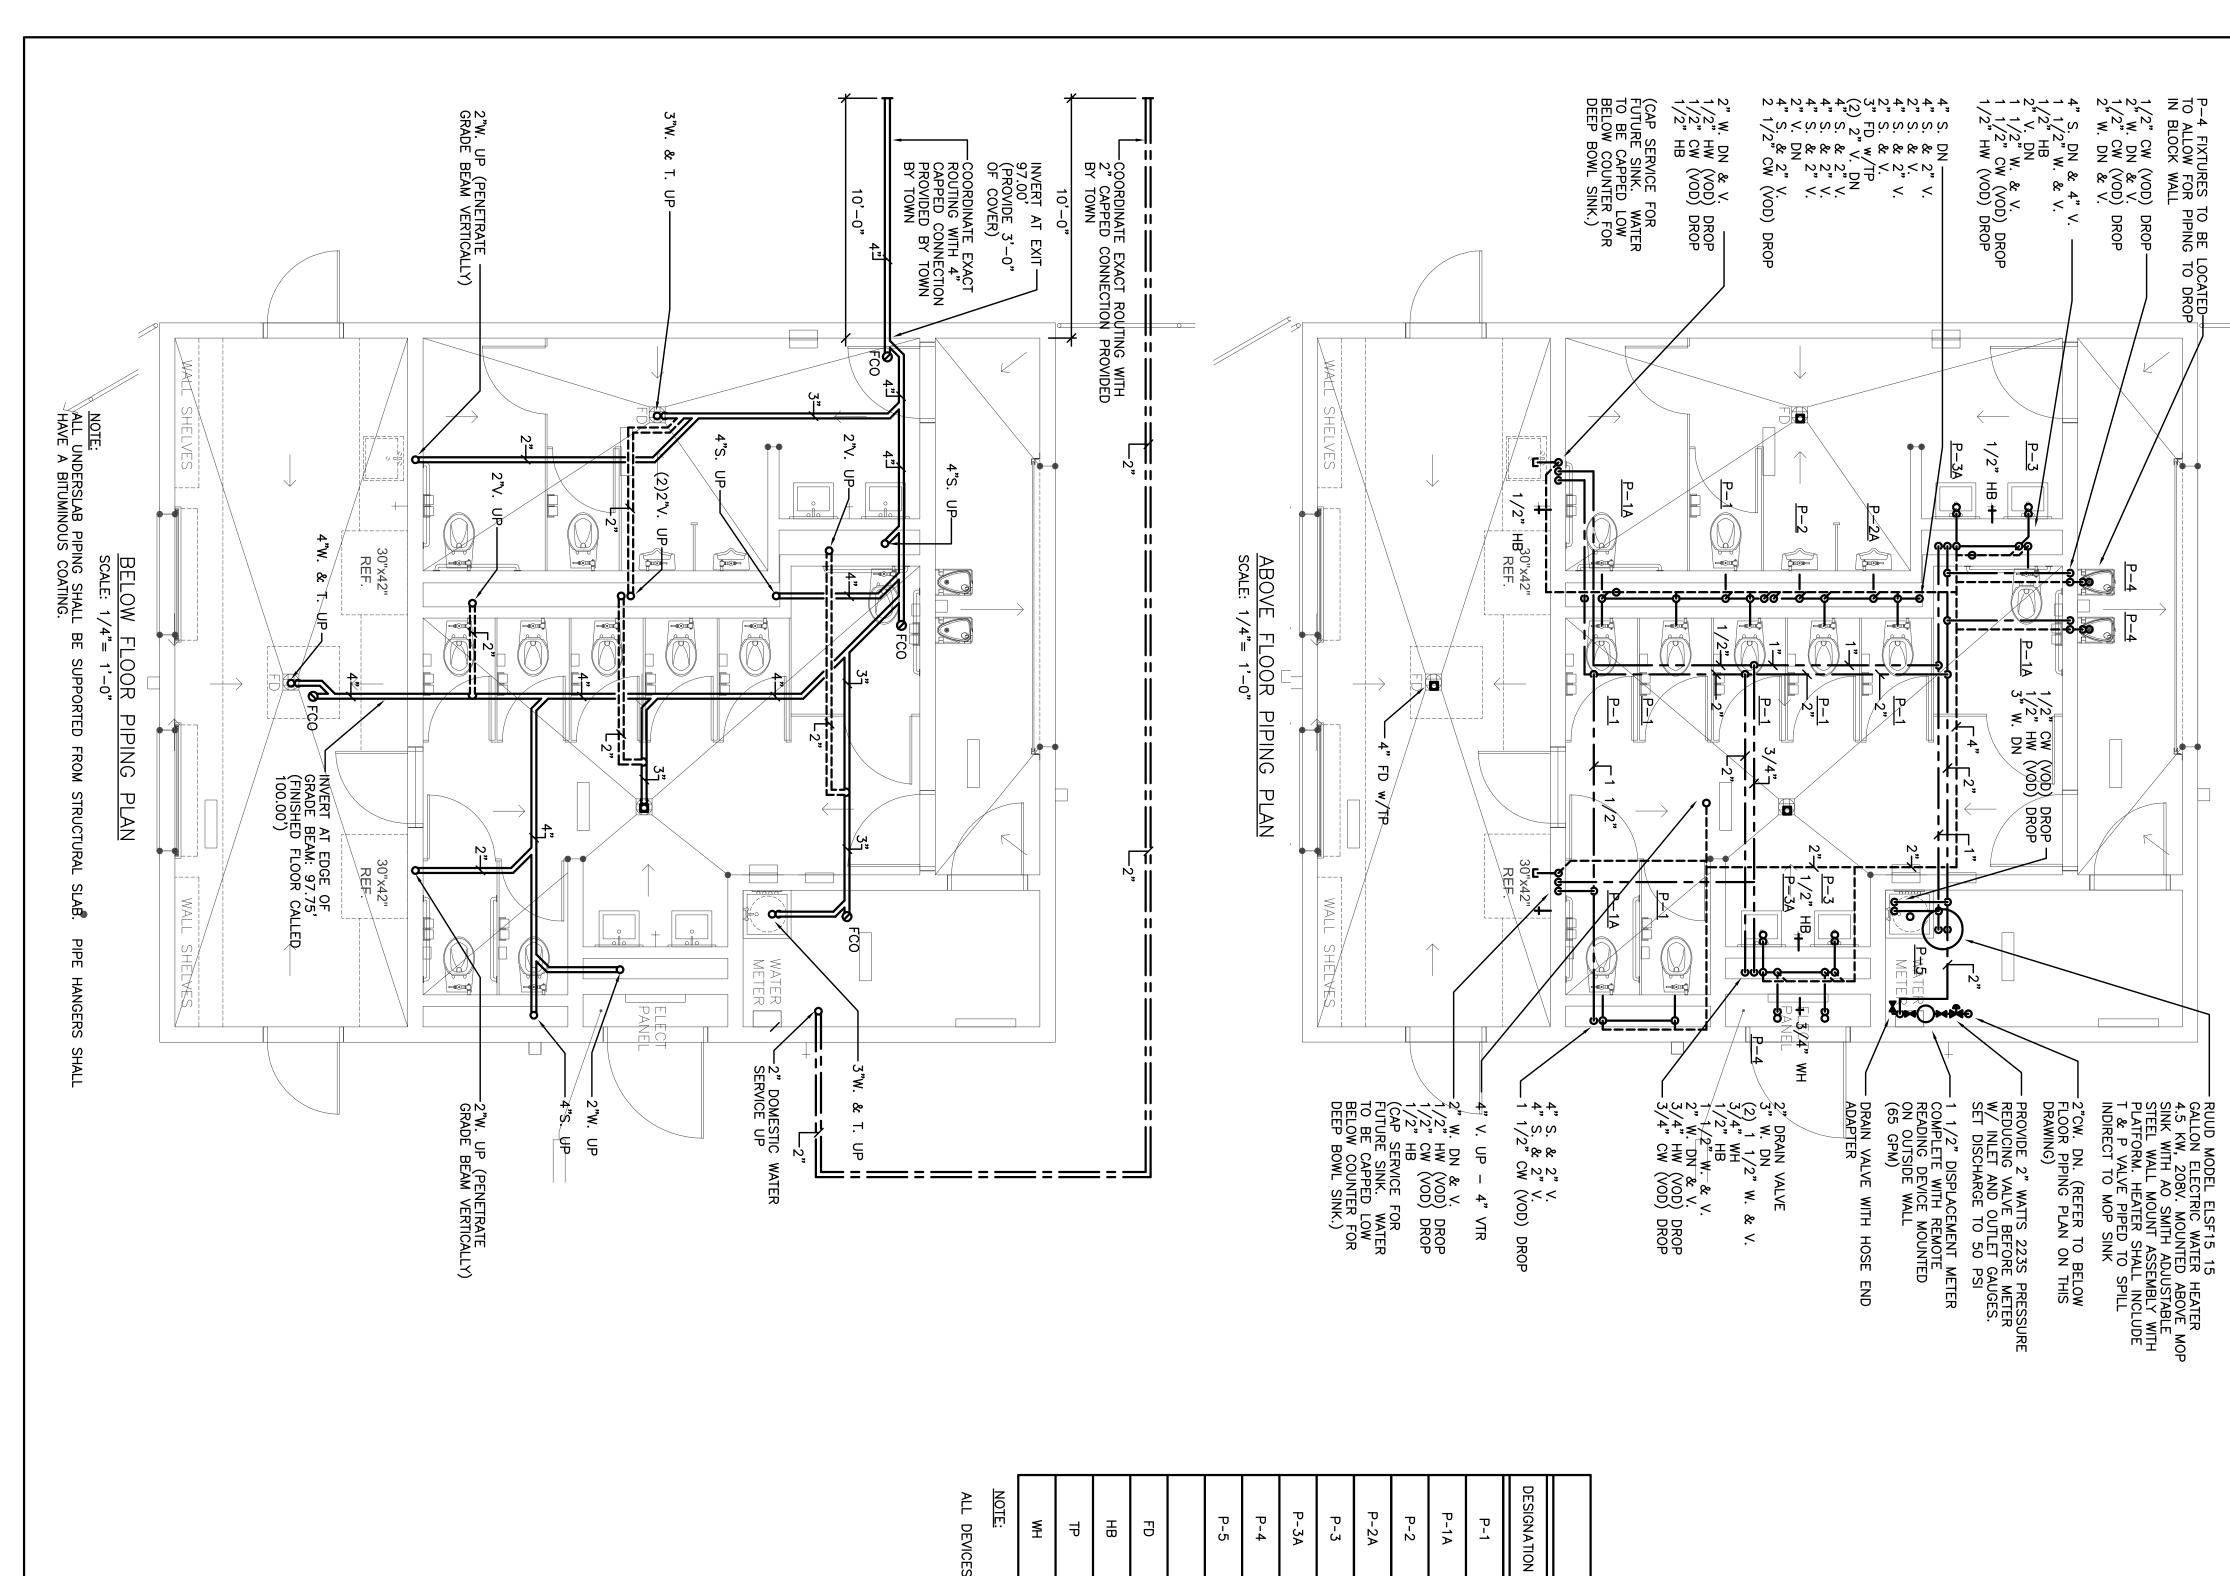

SYMBOL <u>PLUMBING</u> LEGEND: S OR W FC0 **6**00 Ħ ≨ I < H CW Ŧ HOSE BIBB GRADE CLEANOUT FLOOR CLEANOUT VALVE ON DROP WALL HYDRANT TRAP PRIMER FLOOR DRAIN BALL OR GATE VALVE VENT PIPING SANITARY OR WASTE PIPING HOT WATER PIPING COLD WATER PIPING BELOW FLOOR PIPING DESCRIPTION ABOVE FLOOR PIPING OR BURIED

≨

WALL HYDRANT

3/4"

WOODFORD MODEL 24 OR EQUAL COMPLETE WITH SCREW ON BACKFLOW DEVICE.

VANDAL PROOF.

1/2"

PPP PR-500 OR EQUAL PRIME RITE

TRAP PRIMING VALVE ASSEMBLY

WOODFORD MODEL 24 OR EQUAL COMPLETE WITH SCREW ON BACKFLOW DEVICE.

VANDAL PROOF.

8

1/2"

Ħ

HOSE BIBB

LAVATORY

URINAL (ACCESSIBLE)

WATERCLOSET (ACCESSIBLE)

4

Ŋ

2"

TOTO MODEL CT708E OR EQUAL WALL OPEN FRONT SEAT AND JAY R. SMITH OPEN FRONT SEAT AND JAY R. SMITH FLOOF FLUSH VALVE AND JAY R. SMITH FLOOF KOHLER BARDON MODEL K-4904-ET WALVE AND JAY R. SMITH FLOOR BOLT

HUNG 1.28 GPF COMPLETE WITH TOTO TMT1LN-31 MANUAL FLUSH VALVE, TOTO SC534 SIPHON JET HORIZONTAL FOUR BOLT CARRIER TO SUIT. MOUNT AT ACCESSILBE HEIGHT. OR EQUAL WASHOUT URINAL COMPLETE WITH KOHLER K-10949 0.125 GPF DC POWERED R BOLT CARRIER TO SUIT.

ТОТО

SC534

WATERCLOSET

FIXTURE DESCRIPTION

PLUMBING FIXTURE SCHEDULE

REMARKS

MOP SINK

1/2"

1/2"

DRINKING FOUNTAIN

1/2"

1/2"1 1/2"

TWO (2) HAWS MODEL 1047 OR EQU FIAT MODEL MSB2424 OR EQUAL CON

MPLETE WITH 830—AA FAUCET, BUMPERGUARDS AND MSG2424 WALL

WALL MOUNTED DRINKING FOUNTAIN COMPLETE WITH MOUNTING BRACKET AND P-TRAP.

1/2"

1/2"

1/2"

1/2"

TOTO MODEL LT307.4 OR EQUAL WALL WITH KEY STOPS, GRID STRAINER, P-TF TOTO MODEL LT307.4 OR EQUAL WALL KEY STOPS, OFFSET GRID STRAINER, P-

MOUNTED 21"x18" COMPLETE WITH SYMMONS AP AND JAY R. SMITH FLOOR BOLT CARRIER

MODEL S-60-G-H FAUCET, SUPPLIES TO SUIT.

w/ To

1/2"

1/2"

1/2"

1 1/2"

3/4"


Ŋ

LAVATORY (ACCESSIBLE)

뒫

TRAP PRIMER

AND FIXTURES 먪 INSTALLED FOR COMPLETE DRAIN DOWN AND

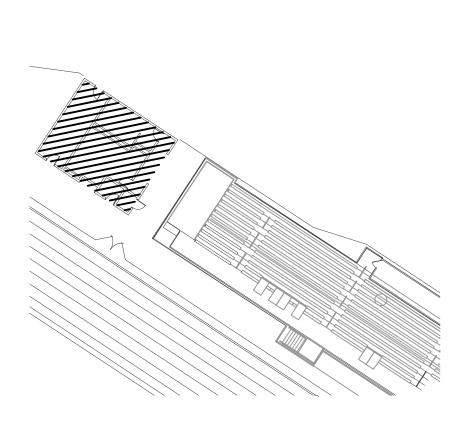

NEWTON SOUTH HIGH SCHOOL FIELD FACILITY BUILDING

140 BRANDEIS ROAD **NEWTON CENTER MASSACHUSETTS 02459**

Plumbing Plan, Legend, Schedule and Specification

Revisions:

architecture

Raymond Design

Associates, Inc.

Hingham, MA 02043

65 Dexter Road Providence, RI 02914 Tel: (401) 438-1635 Fax: (401) 438-0850

222 North Street

SHEET

0F

September 08, 2011

BID SET

Drawn By: Checked By: Approved By:

Drawing Scale

AS NOTED

09154.01

G W J J D

ROUND BRANCH DUCT TAKE-OFF DETAIL NTS	CONN. WITH LIQUID ADHESIVE AND DRAW BAND TYPE CLAMP (IF REQUIRED) FLEXIBLE DUCT, FOR SIZES SEE PLAN FOR ALL ROUND DUCT SIZES SEE PLAN "METALAIRE" MODEL "MD" SPIN—IN FITTING WITH QUADRANT OPERATED ROUND VOLUME DAMPER	LOUVER CONNECTION DETAIL NTS	TOWER PLENUM EXTERNALLY INSULATE STORM—PROOF LOUVER REFER TO SPECIFICATION FOR PROVIDING CONTRACTOR. TO SULDER BOTTOM JOINTS AND SIDES UP 12" FROM BOTTOM ACCESS DOOR 12" X 12" MIN UP 12" FROM BOTTOM UP 12" FROM BOTTOM ALL AROUND SEAL AND CAULK ALL AROUND NOTE: WHEN "D" IS OVER 24" PROVIDE 3/4" BY G.C. NOTE: WHEN "D" IS OVER 24" PROVIDE 3/4" BY G.C.
DIFFUSER IN CEILING CONNECTION DETAIL NTS	CEILING CEILING CEILING CEILING DIRECTIONAL DIFFUSER FACE	ALTERNATE ROUND BRANCH DUCT TAKE-OFF NTS	PREFERENCE TAKE-OFF FITTING T
UNIT HEATER MOUNTING DETAIL	CONNECT THREADEDROD TO UNISTRUT USING SPRING NUTS. 1" UNISTRUT BOLTED TO STRUCTURE VIBRATION ISOLATOR ISOLATOR 8'-0" MIN. TO FLOOR	INLINE-FAN DETAIL	UNIT SHALL BE SUSPENDED FROM CEILING ABOVE WITH THREADED RODS, NUTS, BOLTS, CLAMPS, & VIBRATION ISOLATION HANGERS AIR FLOW AIR FLOW AIR FLOW IN-LINE FAN TRANSITION (TYP.)

		(i.e.)				
	NTS					
			NTS TYP WMS	EXH ELM CAM	AFF (Ø) +	SYMBOL SYMBOL
			NOT TO SCALE OPPOSED BLADE DAMPER TYPICAL WIRE MESH SCREEN	BLAST GATE DAMPER CUBIC FEET PER MINUTE COMPLETE WITH DOWN EXHAUST FAN EXHAUST GRILLE EXISTING TO REMAIN ELECTRIC UNIT HEATER EXHAUST	MANUAL VOLUME DAMPER MOTORIZED DAMPER LOUVERED DOOR SWITCH ABOVE FINISHED FLOOR	HVAC LEGEND DESCRIPTION SUPPLY DIFFUSER RETURN/EXHAUST GRILLE RETURN/EXHAUST DUCT RISE SUPPLY DUCT RISE ROUND DUCT RISE ROUND GRILLE WITH ACOUSTIC BOOT ACOUSTICAL LINING SHOWN WITH DOUBLE LINE DUCT ACOUSTICAL LINING SHOWN WITH SINGLE LINE DUCT
1	Z	1 1	T		\$ 71-TT → O <	T

DIFFUSER TAG CFM AMOUNT NECK SIZE NOTE: THE SQUARE SYMBOL SHALL BE USED FOR ALL EQUIPMENT CALLOUTS THAT DO NOT REQUIRE ELECTRICAL POWER.	USED FOR ALL EQUIPMENT CALLOUTS THAT DO NOT REQUIRE ELECTRICAL POWER.	DESIGNATION NOTE: THE SQUARE SYMBOL SHALL BE	EQUIPMENT TAG	NOTE: THE HEXAGON SYMBOL SHALL BE USED FOR ALL EQUIPMENT CALLOUTS REQUIRING ELECTRICAL POWER HOOK—UP.	EQUIPMENT TAG DESIGNATION	DESCRIPTION	
	BID SET	Date: September 08, 2011	Project Number: 09154.01	Drawing Scale: NONE	Drawn By: FKP Checked By: FKP Approved By: ZW		

HVAC Equipment
Designations

Revisions:

STN

SHEET 1

OF

N

NEWTON SOUTH HIGH SCHOOL FIELD FACILITY BUILDING
140 BRANDEIS ROAD
NEWTON CENTER MASSACHUSETTS 02459

Mechanical Schedules, Details, Legend & General Notes

Associates, Inc.

65 Dexter Road
Providence, RI 02914
Tel: (401) 438-0850

Hingham, MA 02043

Raymond Design 222 North Street Associates, Inc.

architecture

WITHIN THE ATTIC SPACE.


2. ALL FANS SHALL BE LOCATED WITHIN THE ATTIC SPACE.

WITHIN THE ATTIC SPACE.

3. AN ACCESS PANEL (MINIMUM 36"x36") SHALL BE PROVIDED TO ALLOW FOR MAINTENANCE OF EACH FAN.

4. ALL LOUVERS SHALL BE CUSTOM BUILT UNITS LOCATED IN THE GABLE WALLS OF THE BUILDING. THE UNITS SHALL BE APPROVED BY THE BUILDING OWNER AND ARCHITECT BEFORE THEY ARE PURCHASED.

5. ALL LOUVERS SHALL HAVE HAVE A MINIMUM FREE AREA AS INDICATED.

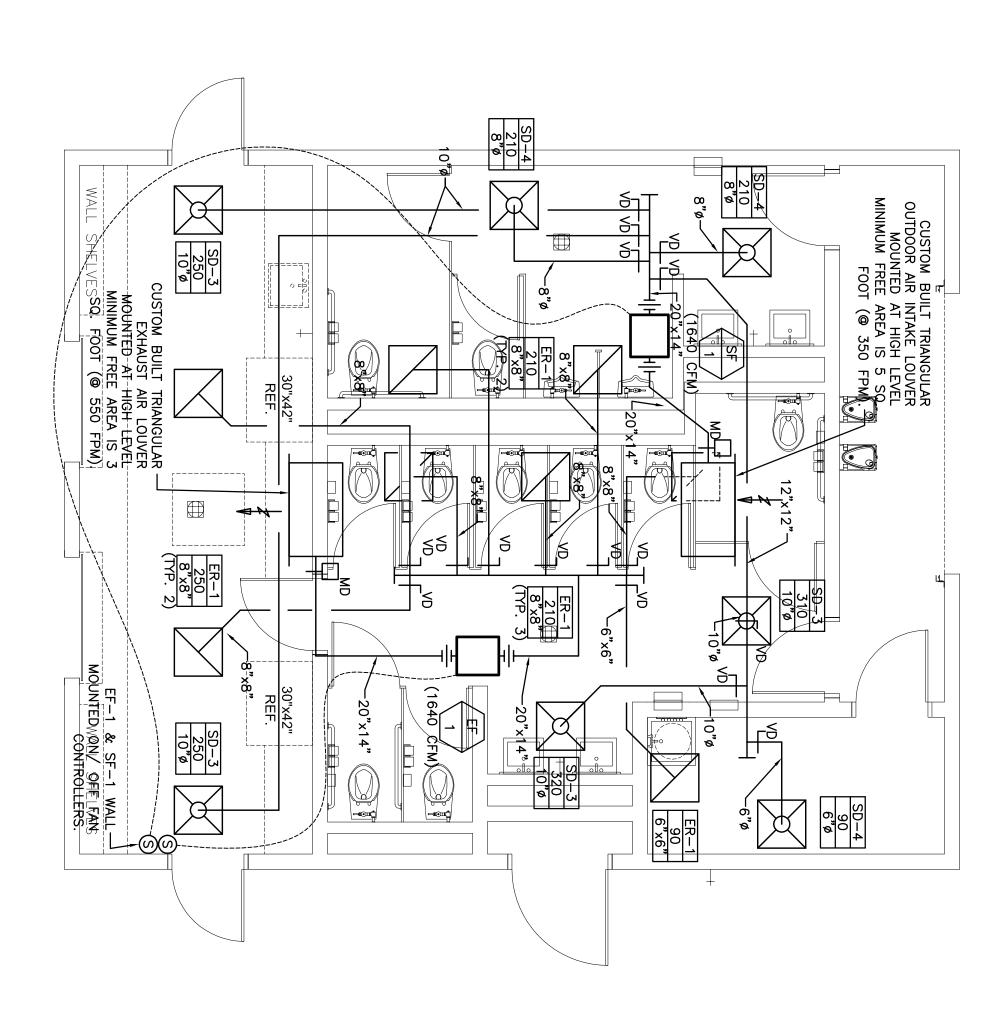

cale: 1/4"=1'-0"

Revisions:

No. Date Description

Date Description

FKP
Checked By: FKP
Approved By: ZW

Prawing Scale: AS NOTED

Project Number: 09154.01

Date: September 08, 2011

BID SET

SHEET

N

QF

2

NEWTON SOUTH HIGH SCHOOL FIELD FACILITY BUILDING 140 BRANDEIS ROAD NEWTON CENTER MASSACHUSETTS 02459

Mookaniaal

Mechanical New Work Floor Plan WOZNY/ BORDOR & ASSOCIO
CONSULTING ENGINEERS


1090 Weshington Street
Hander, M. 02339
181: (781) 828-4144
Fat: (781) 828-5023
181: (781) 828-5023
181: (781) 828-6023
181: (781) 828-6023
181: (781) 828-6023
181: (781) 828-6023
181: (781) 828-6023
181: (781) 828-6023

3arbar & Associates, Inc Naineers

ton Street 65 Dector Roo 22339 Providence, Ril 0291. Hingham, MA 02043

222 North Street

Raymond Design
Associates, Inc.

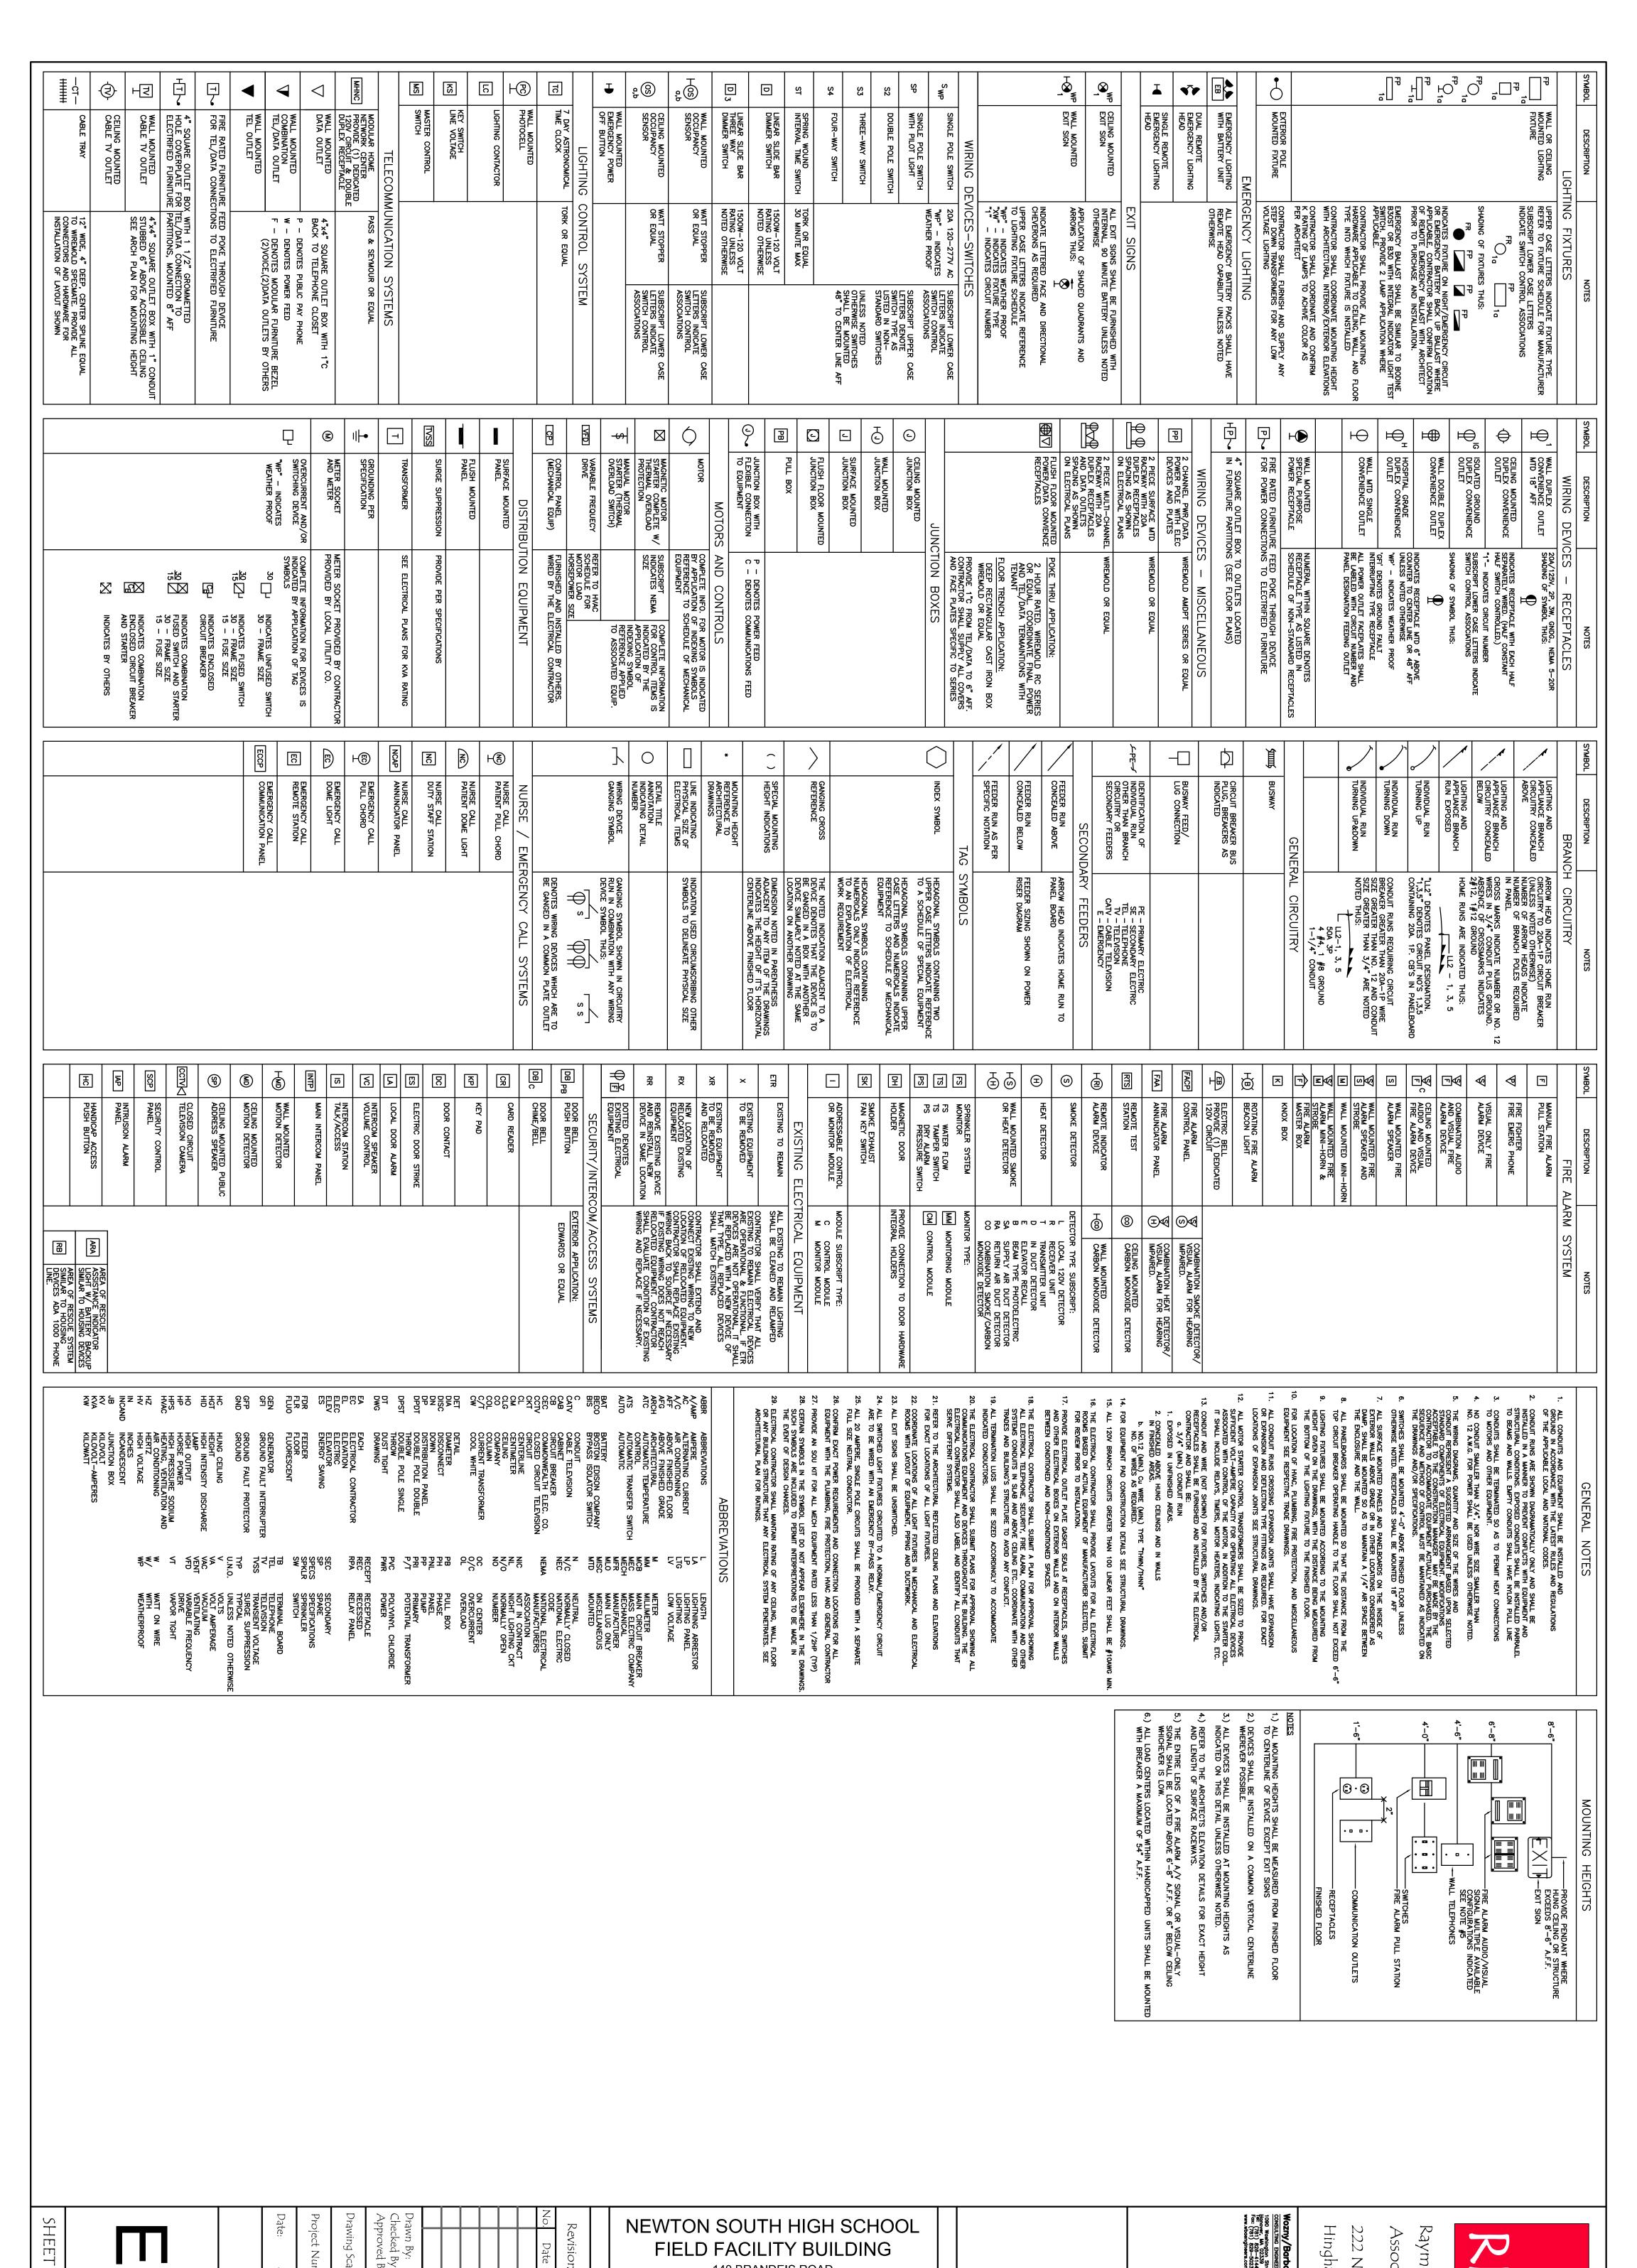

<u>~</u>

QF

ယ

Drawn By: Checked By: Approved By: Drawing Scale Revisions: September 08, 2011 BID SET PMG JJK MR NONE 09154 01

FIELD FACILITY BUILDING 140 BRANDEIS ROAD


NEWTON CENTER MASSACHUSETTS 02459

Electrical Legend and General Notes



Raymond Design Hingham, MA 02043 222 North Street Associates, Inc.



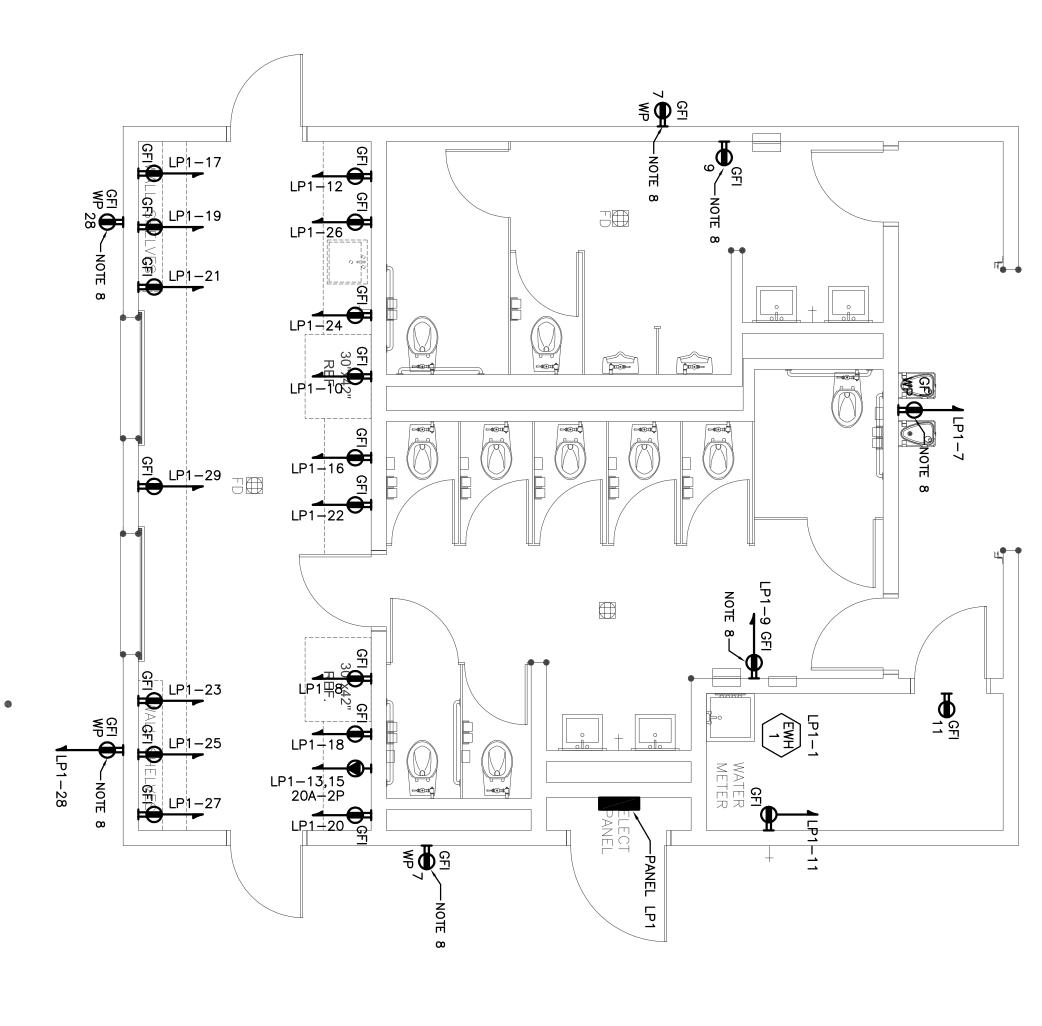

47

12a

12b

▼ 0 % %

°و ک

12a

12b

FR 1

FR1

12 83 S

12

TO EB (TYPICAL)

№1



Scale: 1/4"=1'-0"

1. SEE DRAWING EO.O FOR ELECTRICAL LEGEND AND GENERAL NOTES.

POWER NOTES:

- 2. COORDINATE EXACT ELECTRICAL DEVICE MOUNTING HEIGHTS AND LOCATIONS WITH ARCHITECTURAL CASEWORK OR ARCHITECTURAL INTERIOR/EXTERIOR ELEVATION DRAWINGS.
- COORDINATE COLOR OF RECEPTACLE FACEPLATES AND DEVICES WITH ARCHITECT PRIOR TO ORDERING EQUIPMENT. CIRCUIT NUMBER DESIGNATIONS ARE INTENDED TO ILLUSTRATE BRANCH WIRING CONFIGURATION ONLY.
- ALL POWER/DATA OUTLET FACEPLATES SHALL BE LABELED WITH CIRCUIT NUMBER FEEDING OUTLET AND PANEL DESIGNATION. LABEL STYLE AND SIZE SHALL MATCH BASE BUILDING STANDARDS. CONTRACTOR SHALL COORDINATE COLOR, SIZE AND METHOD OF LABELING WITH ARCHITECT.
- ALL EXPOSED AND SURFACE MOUNTED CONDUIT SHALL BE GALVANIZED RIGID STEEL.
- CONTRACTOR SHALL WIRE NEW EXHAUST FAN TO LIGHTING CONTROL. WHEN LIGHTING IS TURNED ON WITHIN BATHROOMS, EXHAUST FAN SHALL TURN ON. POWER RECEPTACLE SHALL BE RECESSED WITHIN WALL. CONTRACTOR SHALL FURNISH AND INSTALL BACKBOX, AND LOCKABLE, COVER. PASS & SEYMOUR OR APPROVED EQUAL. PASS & SEYMOUR CATALOG NUMBERS: COVER: 4600, MOUNTING PLATE: 460026P, KEY: 4609.

LIGHTING NOTES:

S3c

w1 O₅

FR1

FR1

FR1

SaSb

12c


S3c

REFER TO EMERGENCY LIGHTING WIRING DIAGRAMN ON DWG E2.0 (TYPICAL)

- SEE DRAWING EO.O FOR ELECTRICAL LEGEND AND GENERAL NOTES.
- COORDINATE SWITCHING AND LIGHTING FIXTURE LOCATIONS WITH ARCHITECTURAL CASEWORK OR INTERIOR ELEVATION DRAWINGS. COORDINATE EXACT LIGHTING FIXTURE LOCATIONS AND LENGTHS WITH ARCHITECTURAL REFLECTED CEILING PLAN.
- ALL NEW EQUIPMENT SHALL MATCH BASE BUILDING STANDARDS AND SPECIFICATIONS, UNLESS NOTED OTHERWISE. ALL NEW EQUIPMENT SHALL BE COMPATIBLE WITH THE EXISTING SYSTEM
- CIRCUIT NUMBER DESIGNATIONS ARE INTENDED TO ILLUSTRATE BRANCH WIRING CONFIGURATION ONLY. PROVIDE "HOT" UNSWITCHED POWER AT ALL LIFE SAFETY BATTERY UNITS.
- CONTRACTOR SHALL COORDINATE ALL LIGHTING WITH NEW SYSTEMS ABOVE CEILING PRIOR TO INSTALLATION. CONTRACTOR SHALL RESOLVE ANY INSTALLATION CONFLICTS IN FIELD AND NOTIFY ARCHITECT OF CHANGE. ALL EMERGENCY BATTERY PACKS SHALL BE SUPPLIED WITH CONTACTS TO ACCEPT REMOTE EMERGENCY HEADS.
- ALL FIXTURES UTILIZING HID LAMPS SHALL MEET THE ENERGY INDEPENDANT AND SECURITY ACT "EISA" ALL EXPOSED AND SURFACE MOUNTED CONDUIT SHALL BE GALVANIZED RIGID STEEL.

700

Scale: 1/4"=1'-0"

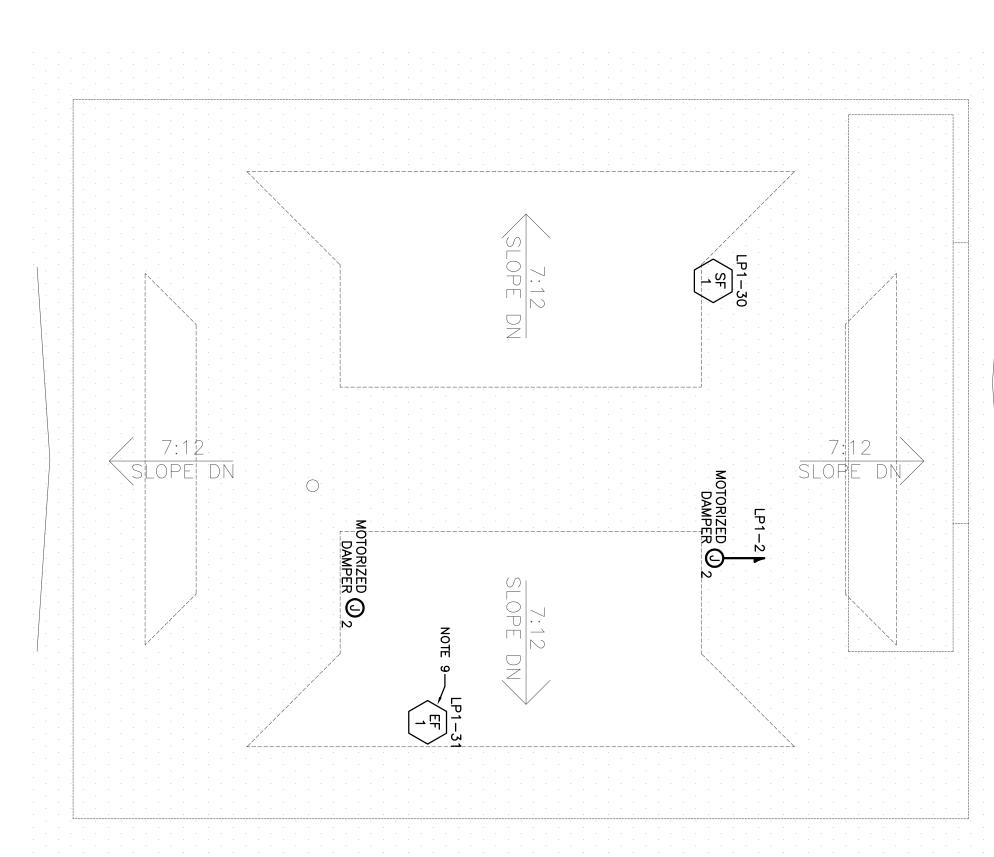

No.	Re	NE	EWTON SOUTH HIGH
Date	Revisions:		FIELD FACILITY BUIL
(0	ns:		140 BRANDEIS ROAD
De			NEWTON CENTER MASSACHUSE
SCri			
Description			Electrical

SCHOOL LDING

ETTS 02459 Lighting and Power Floor Plans

Raymond Design Associates, Inc. architecture

Hingham, MA 02043

65 Dexter Road Providence, RI 02914 Tel: (401) 438-1635 Fax: (401) 438-0850

222 North Street

SHEET

2

OF

ယ

Drawn By: Checked By: Approved By:

PMG JJK MR

Drawing Scale:

NONE

September 08, 2011

09154.01

BID SET

													T											
н⊗		ę	>				W2		-	¥		FR2		FR1		TYPE				PEN	C			
EXIT SIGN WITH VANDAL RESISTANT SHIELD		TURE	WALL MOUNTED DUAL HEAD REMOTE	HEAD CAPACITY	HEAD EMERGENCY FIXTURE WITH REMOTE	WALL MOUNTED DUAL	WIRE GUARD	2' STRIP WITH	WITH PHOTOCELL	EXTERIOR VANDAL RESISTANT WALL SCONCE		VANDAL RESISTANT	מינים מינים	LENSED FIXTURE	RECESSED 2'x4'	DESCRIPTION		TRACK	WALL	PENDANT/SUSPENDED	CEILING/SURFACE	RECESSED	MOUNTING	
RAZOR SERIES RZREMR1WSLC	EVENLITE:	PW1292WG4	EVENLITE: PHOENIX PW SERIES		TUFFLITE DT SERIES DT4E1002W129H	EVENI ITE:	CN2114EFOWG	COLUMBIA LIGHTING		HUBBELL: NRG306BPCW	-	COLUMBIA: 4VS22317MFSDR12E UTP6		UTP6	COLUMBIA:	CATALOG NUMBER	MANII IEACTI IDED 8	FT	FW	FP	FC	FR	FLUORESCENT	LIGHTIN
LED		٨	ა		2				-	<u>.</u>		G		IJ		NUMBER							INCAND	NG FIXTU
Б		NOT	9W		TUN We		14w T5	4	CF F	26W	3500K	F017W T8		78 3500K		TYPE	AMPS	→	₩	סד	С	R	INCANDESCENT/HID	LIGHTING FIXTURE SCHEDULE
MVOLT		-	3		12		MVOLT			NO T		MVOLT		MVOLT		VOLTS	=						-	ULE
⇉		ō	ô		1 8		14		6) 6		41		96		WATTS	NPLIT		WX	ΧP	xc	XR	EXIT	
PROVIDE VANDAL RESISTANT COVER NOTE 1	FINISH BY ARCHITECT		PROVIDE WIRE GUARD NOTE 1		NOTE 1	PROVIDE INTERNAL HEATER	NO.	FINISH BY ARCHITECT	FINISH BY ARCHITECT	FINISH BY ARCHITECT NOTE 1		NOTE 1			FINISH BY ARCHITECT	REMARKS								
Γ	1600	1200	1000	800	600	400	350	300	250	225	200	175	150	125	100	60 00	50-		30-	Τ				
⊢	1600-3G 1	1200-3G 9	1000-3G 9 ₁	800-3G 6	600-3G 6	400-3G 3 ₁	350-3G 3	300-3G 3	250-3G 3;	225–3G 3 ₁	200–36 3 ₁	175-36 3	150-36 3	125-3G 3	100-36 3	60-3G 3;	50-3G 3	1	30-36 3	+	<u> </u>	<u> </u>		
-11	12#600 KCMIL & 4#4/0 GND.	9#600 KCMIL & 3#3/0 GND.	9#400 KCMIL & 3#2/0 GND.	6#600 KCMIL & 3#1/0 GND.	6#350 KCMIL & 2#1 GND.	3#500 KCMIL & 1#3 GND.	3#500 KCMIL & 1#3 GND.	3#350 KCMIL & 1#4 GND.	3#250 KCMIL & 1#4 GND.	3#4/0 & 1#4 GND.	3#3/0 & 1#6 GND.	3#2/0 & 1#6 GND.	3#1/0 & 1#6 GND.	3#1 & 1#6 GND.	3#3 & 1#8 GND.	3#6 & 1#10 GND.	3#8 & 1#10 GND.		3#10 & 1#10 GND.		3 WIRE) WITH GROUND	CONDUCTORS (3 PHASE		LEGEND OF FE

	_	_
1. CONTRACTOR SHALL CONFIRM CEILING/WALL CONSTRUCTION WITH ARCHITECT PRIOR TO PURCHASE AND PRO	NOTES:	
w		
OVIDE APPROPRIATE TRIM KIT FOR FIXTURE		
•		

1#1TS#2	dz _vos						
3#8+1#1(40A-3P						
3#10+1#1	30A-3P	000	+-3 /2	IOFFOUL NUMBER OF 474/U GNU.	1000	1	!
3#12+1#1	20A-3P	1600	4_3 1/. "	10 1000 1001111 2 4 11 10 0010	1600-10	7 - 3"	7
C	CIRCUIT BREAKER	1200	3-3 1/2*	12#600 KCMIL & 3#3/0 GND.	1200-46	3-3"	•
-TS, 3ø, 3W	208 OR 480 VOLTS,	1000	3-3"	12#400 KCMIL & 3#2/0 GND.	1000-4G	3-3"	•
3#6+1#10	60A-2P	800	2-3 1/2*	8#600 KCMIL & 3#1/0 GND.	800-4G	2-3"	•-
3#6+1#10	50A-2P	600	2-3"	8#350 KCMIL & 2#1 GND.	600-4G	2-3"	
3#8+1#10	40A-2P	4 00	4,	4#500 KCMIL & 1#3 GND.	400-4G	ų	1
3#10+1#1	30A-2P	300		4#300 RCMIL & I#3 GND.	000	,	
3#12+1#1	20A-2P	3 50	Ą	8. 4 <i>H</i> 7	350_40	4	
C	CIRCUIT BREAKER	300	3,	4#350 KCMIL & 1#4 GND.	300-4G	21/2*	
1ø, 3W CIRC	208/120 VOLT, 1	250	21/2"	4#250 KCMIL & 1#4 GND.	250-4G	2 1/2 "	1 1
2#6+1#10	60A-2P	225	21/2"	4#4/0 & 1#4 GND.	225-4G	2**	
2#6+1#10	50A-2P	200	2"	4#3/0 & 1#6 GND.	200-4G	2**	
2#8+1#1(40A-2P	175	2"	4#2/0 & 1#6 GND.	175-4G	2,*	
2#10+1#1	30A-2P	-50	^	4#1/0 & 1#0 GND.	100-46	2	
2#12+1#1	20A-2P	150	١	/o e 1 #6	150 10	11/ *	
CC	CIRCUIT BREAKER	125	1 1/2 "	4#1 & 1#6 GND.	125-46	1 1/4 "	
2W. CIRCUIT	208 VOLT 1ø,	100	11/4"	4#2 & 1#8 GND.	100-4G	1 1/4 "	
2#6+1#10	60A-1P	60	۳,	4#6 & 1#10 GND.	60-4G	3/4"	
2#6+1#10	50A-1P	50	3/4°C.	4#8 & 1#10 GND.	50-4G	3/4"	
2#8+1#10	40A-1P	30	3/4°C.	4#10 & 1#10 GND.	30-4G	3/4"	
2#10+1#1	30A-1P						
c	CIRCUIT BREAKER	RATING	SIZE	4 WIRE) WITH GROUND	TAG	SIZE	
lø, 2W. CIRO	120 OR 277 VOLT 1¢,	NOMINAL	RACEWAY)		RACEWAY	
ITS SCHEDU	BRANCH CIRCUITS	<i>S</i>	CONDUCTORS	COPPER	SIZES-	FEEDER	
							ı

LEGEND OF

480Y/277 VOLT, 3ø,4W CIRCUITS conductor 4#12+1#12 GND 3/4°C 4#8+1#10 GND 3/4°C 4#6+1#10 GND 3/4°C	
'277 VOLT, 3ø,4W CIRC conductor 4#12+1#12 gnd 4#10+1#10 gnd 4#8+1#10 gnd	50A-3P
'277 VOLT, 3ø,4W CIRC CONDUCTOR 4#12+1#12 GND 4#10+1#10 GND	40A-3P
'277 VOLT, 3ø,4W CIRC conductor 4#12+1#12 GND	30A-3P
, 277 VOLT,	20A-3P
, 277 VOLT,	CIRCUIT BREAKER
2 2	208Y/120 & 48
3#6+1#10 GND 3/4"C	60A-3P
3#6+1#10 GND 3/4°C	50A-3P
3#8+1#10 GND 3/4°C	40A-3P
3#10+1#10 GND 3/4°C	30A-3P
3#12+1#12 GND 3/4°C	20A-3P
CONDUCTOR	CIRCUIT BREAKER
480 VOLTS, 3ø, 3W CIRCUITS	208 OR -
3#6+1#10 GND 3/4°C	60A-2P
3#6+1#10 GND 3/4°C	50A-2P
3#8+1#10 GND 3/4°C	40A-2P
3#10+1#10 GND 3/4°C	30A-2P
3#12+1#12 GND 3/4°C	20A-2P
CONDUCTOR	CIRCUIT BREAKER
VOLT, 1ø, 3W CIRCUITS	208/120
2#6+1#10 GND 3/4"C	60A-2P
2#6+1#10 GND 3/4°C	50A-2P
2#8+1#10 GND 3/4°C	40A-2P
2#10+1#10 GND 3/4°C	30A-2P
2#12+1#12 GND 3/4°C	20A-2P
CONDUCTOR	CIRCUIT BREAKER
VOLT 10, 2W. CIRCUITS	208 VC
2#6+1#10 GND 3/4°C	60A-1P
2#6+1#10 GND 3/4°C	50A-1P
2#8+1#10 GND 3/4°C	40A-1P
2#10+1#10 GND - 3/4°C	30A-1P
CONDUCTOR	CIRCUIT BREAKER

CONNECT TO CIRCUIT IN A AHEAD OF C

NOTE:
REFER TO FLOOR PLANS FOR EFOR EXACT LOCATIONS.

ATIONS, SEE ARCHITECTURAL REFLECTED CEILING PLANS

WIRING DISTANCES IN FEET

Electrical Handhole Detail	

ELECTRIC WATER HTR

3/4

120 120 208

5 5 5

20/1P 30/2P

30

20/1P

C/B SIZE

RTS S_D

REFER TO SCHEDULE
REFER TO SCHEDULE

3/4

PROVIDE SURFACE MOUNTED, WEATHER PROOF, INDUSTRIAL "JELLY JAR" LIGHT FIXTURE. FIXTURE MOUNTED TO MECHANICAL STONCO: ROUGHLYTE SERIES OR EQUAL. CONTRACTOR TO PROVIDE LAMP AND WEATHER PROOF, SWITCH.

PROVIDE SURFACE MOUNTED, WEATHER PROOF, GFI, DUPLEX RECEPTACLE. RECEPTACLE MOUNTED TO MECHANICAL UNIT. REFER TO ELECTRICAL PLANS FOR EXACT LOCATIONS AND QUANTITIES.

CONTRACTOR TO COORDINATE EXACT LOCATION IN FIELD WITH OWNER/ARCHITECT PRIOR TO INSTALLATION.

Mal

EQUIPMENT DESCRIPTION

MECHANICAL

EQUIPMENT CONNECTION SCHEDULE

EXISTING SLP1

IJ

 ∇

 ∇

 ∇

5

100

성 당 寸 성 당 寸 표 BKR POLES

VOLTS

PHASE

WIRES

MAINS
MAIN LUGS ONLY
OVERCURRENT
DEVICE
TRIP FRAME

PANELBOARD SCHEDULE

BRANCH DEVICES

MOUNTING: S=SURFACE F=FLUSH

SIZE


120/208 | 120/208

	EXISTING EXISTING
PROPOSED NEW PANEL LP1	EXISTING ENCLOSURE —
NEW	

SLP1 225A MLO 120/208V 3ø 4W SE/UL

- NEMA 3R 200A 3P FUSE 200A CLASS RK-5 RT/SN 250V

NEW ELECTRICAL— HAND HOLE

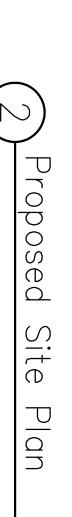

CONTRACTOR SHALL FIELD VERY AND CONFIRM EXACT ROUTING OF CONDUUIT AND PULLBOX WITH ARCHITECT AND CIVIL ENGINEER.
 ALLOW 160' OF NEW FEEDER FOR BIDDING PURPOSES. PROVIDE UNIT PRICE, PER FOOT, PER FEEDER AND CONDUIT.
 SEE POWER RISER DIAGRAM AND FLOOR PLANS FOR ADDITIONAL INFORMATION.

1. CONTRACTOR SHALL FURNISH AND INSTALL (1) 100A/3P BREAKER WITHIN EXISTING PANLE SLP1 TO FEED NEW PANEL LP1.
2. REFER TO FLOOR PLANS, SCHEDULES, AND SITE PLAN FOR ADDITIONAL INFORMATION.
3. HANDHOLE SHALL BE QUAZITE COMPOSITE STACKABLE OR EQUAL.
4. CONDUIT SHALL BE PVC SCHEDULE 40

Proposed

Electrical

Power

Riser

Scale: NTS

SHEET

ယ

0F

ယ

Drawn By: Checked By: Approved By:

PMG JJK MR

Revisions:

Drawing Scale

NONE

September 08, 2011

09154.01

BID SET

NEWTON SOUTH HIGH SCHOOL FIELD FACILITY BUILDING

140 BRANDEIS ROAD NEWTON CENTER MASSACHUSETTS 02459

Electrical Risers, Schedules and Details

Raymond Design Associates, Inc. architecture

120V NORMAL POWER CONTINUE TO ADDITIONAL EXIT SIGNS (SEE FLOOR PLANS)

PROVIDE DUPLEX RECEPTACLE AT BATTERY UNIT IF REQUIRED

2#12,1/2"C (TYPICAL)

20A.,1P. CIRCUIT BREAKER WITH LOCK ON DEVICE

LABEL PANEL INDEX EMERGENCY LIGHTING

Hingham, MA 02043

65 Dexter Road Providence, RI 02914 Tel: (401) 438-1635 Fax: (401) 438-0850

222 North Street